

**DIMENSION NOTES:**

ALL DIMENSIONS ARE MEASURED AS FOLLOWS:

- INTERIOR STUD WALLS ARE DIMENSIONED TO THE CENTER LINE OF THE WALL.
- EXTERIOR WALLS ARE DIMENSIONED TO THE OUTSIDE FACE OF THE BRICK VENEER/BRICK LEDGE TO EXTERIOR FACE OF STUDS.
- DIMENSIONS DENOTED AS "CLEAR" INDICATES A CLEAR DIMENSION THAT IS REQUIRED BETWEEN FACE OF FINISH SURFACE TO FACE OF FINISH SURFACE OR FINISH SURFACE OF OPPOSING ELEMENT.
- SEE ENLARGED FLOOR PLAN AREAS AS DENOTED ON WALL PARTITION / ARCHITECTURAL FLOOR PLAN FOR ADDITIONAL DIMENSIONS.

**GENERAL & WALL TYPE NOTES:**

1. ALL INTERIOR WALLS AND PARTITIONS ARE FULL HEIGHT AND EXTEND FROM THE FLOOR TO THE UNDERSIDE OF THE ROOF DECK ABOVE UNLESS SPECIFICALLY NOTED OTHERWISE.
2. REFER TO FLOOR PLANS AND INTERIOR ELEVATIONS FOR ADDITIONAL FURRING REQUIREMENTS THAT MAY NOT BE SHOWN ON THIS DRAWING.
3. REFER TO EXTERIOR WALL SECTIONS AND DETAILS FOR EXTERIOR WALL ASSEMBLIES.
4. IF WALL IS SCHEDULED TO RECEIVE TILE OR MASONRY, PROVIDE CONCRETE BOARD AND WATERPROOFING FOR TILE INSTALLATION. REFER TO FINISH SCHEDULE, INTERIOR ELEVATIONS AND SECTIONS, AND GYPSUM BOARD ASSEMBLIES SPECIFICATIONS FOR TYPES AND ADDITIONAL SUBSTRATE/FURRING REQUIREMENTS.
5. REFER TO STRUCTURAL FOR ADDITIONAL WALL REQUIREMENTS.
6. PROVIDE TWO 5'X6' 4" THK. CONC. SLABS AT BOTH REAR DOORS. PROVIDE 6'X6'-W1.4 X W1.4 W.W.F. PROVIDE MIN. 1/4" SLOPE/FT. AWAY FROM BUILDING.

**WALL TYPE LEGEND**

**[1.2']** PARTITION TAG

- 1 THE FIRST CHARACTER IN THE TAG REFERENCES THE PARTITION TYPE
- 2 THE SECOND CHARACTER IN THE TAG REFERENCES THE THICKNESS OF THE STRUCTURE (CMU, METAL STUD, WOOD, ETC.)

\* REFER TO INTERIOR ELEVATIONS AND ASSOCIATED WALL SECTIONS AND DETAILS FOR ADDITIONAL FURRING REQUIREMENTS AND FINISHES NOT SHOWN ON WALL TYPE PLAN SCHEDULE.


**[MCJ]** MASONRY CONTROL JOINT (SUGGESTED LOCATION)

PROVIDE KEYED RUBBER MASONRY CONTROL JOINTS AT 25'-4" MAXIMUM. COORDINATE LOCATIONS IN FIELD WITH ARCHITECT. REFER TO EXTERIOR ELEVATIONS FOR SUGGESTED JOINTS AT EXTERIOR WALLS. REFER TO STRUCTURAL DRAWINGS AND DETAILS FOR ADDITIONAL MCJ REQUIREMENTS. CONTRACTOR RESPONSIBLE FOR LOCATING JOINTS PER STRUCTURAL REQUIREMENTS.

**[GCJ]** GYPSUM CONTROL JOINT (SUGGESTED LOCATION)

PROVIDE GYPSUM CONTROL JOINTS IN ACCORDANCE WITH "APPLICATION AND FINISHING OF GYPSUM PANEL PRODUCTS GA-216" AND ASTM C840 "STANDARD SPECIFICATION FOR APPLICATION AND FINISHING OF GYPSUM BOARD". PROVIDE BLOCKING BEHIND CONTROL JOINTS IN FIRE-RATED SYSTEMS IN ACCORDANCE WITH GA-234 "CONTROL JOINTS ARE FIRE-RESISTANCE RATED SYSTEMS".


**TYPE A**

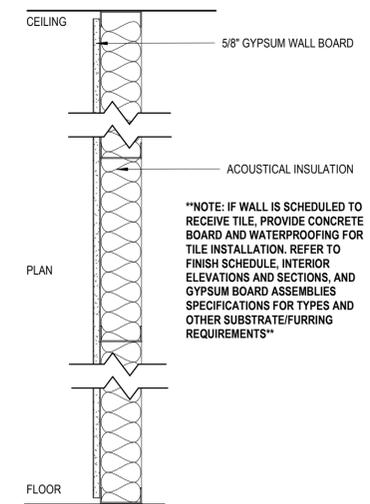

\*\*NOTE: IF WALL IS SCHEDULED TO RECEIVE TILE, PROVIDE CONCRETE BOARD AND WATERPROOFING FOR TILE INSTALLATION. REFER TO FINISH SCHEDULE, INTERIOR ELEVATIONS AND SECTIONS, AND GYPSUM BOARD ASSEMBLIES SPECIFICATIONS FOR TYPES AND OTHER SUBSTRATE/FURRING REQUIREMENTS\*\*



TYPE	STUD...	PARTITION THICKNESS
A0.1	1 1/2"	1 1/8"
A0	7/8"	1 1/2"
A2	1 5/8"	2 1/4"
A2	2 1/2"	3 1/8"
A3	3 5/8"	4 1/4"
A4	4"	4 5/8"
A6	6"	6 5/8"
A8	8"	8 5/8"

**TYPE C**

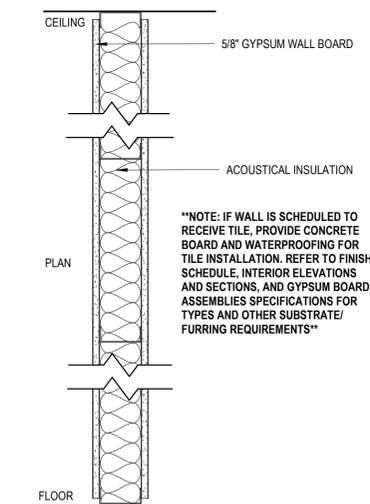


\*\*NOTE: IF WALL IS SCHEDULED TO RECEIVE TILE, PROVIDE CONCRETE BOARD AND WATERPROOFING FOR TILE INSTALLATION. REFER TO FINISH SCHEDULE, INTERIOR ELEVATIONS AND SECTIONS, AND GYPSUM BOARD ASSEMBLIES SPECIFICATIONS FOR TYPES AND OTHER SUBSTRATE/FURRING REQUIREMENTS\*\*

TYPE	STUD...	PARTITION THICKNESS
C1	1 5/8"	2 7/8"
C2	2 1/2"	3 3/4"
C3	3 5/8"	4 7/8"
C4	4"	5 1/4"
C6	6"	7 1/4"
C8	8"	9 1/4"

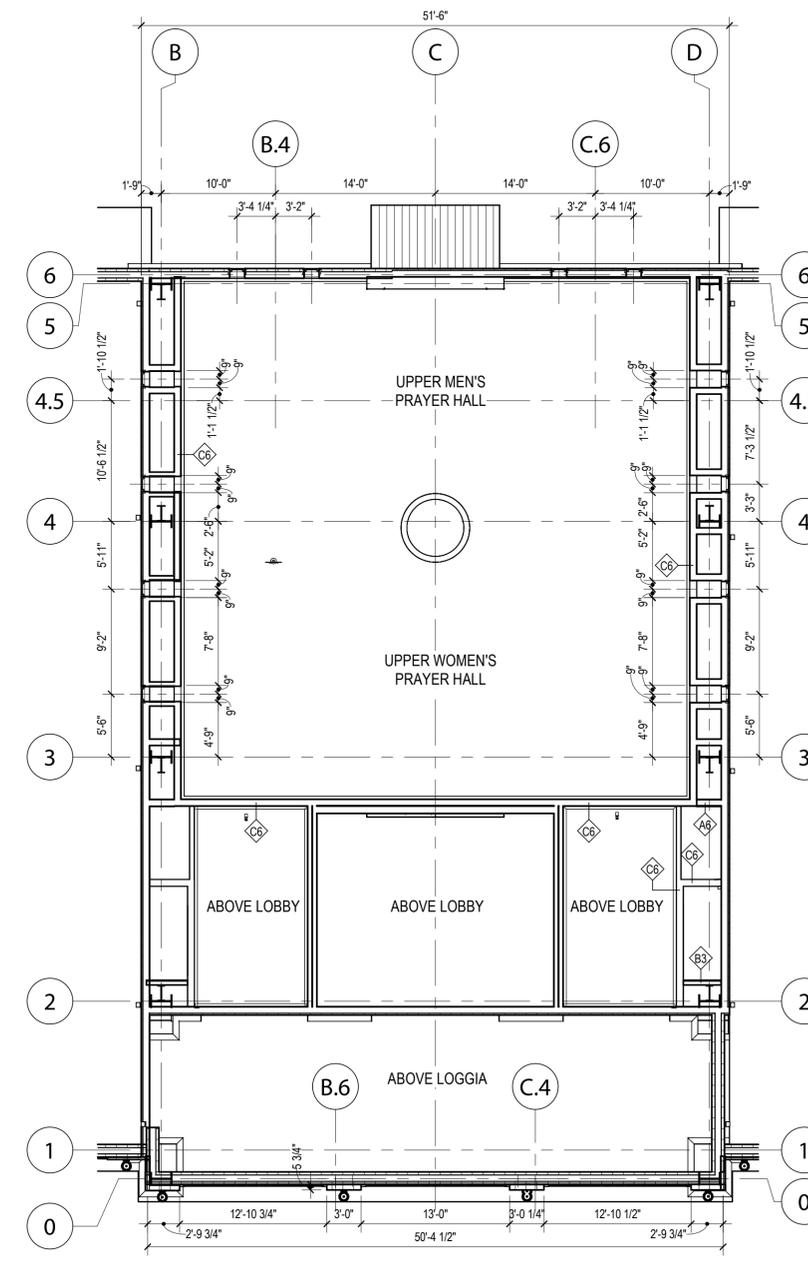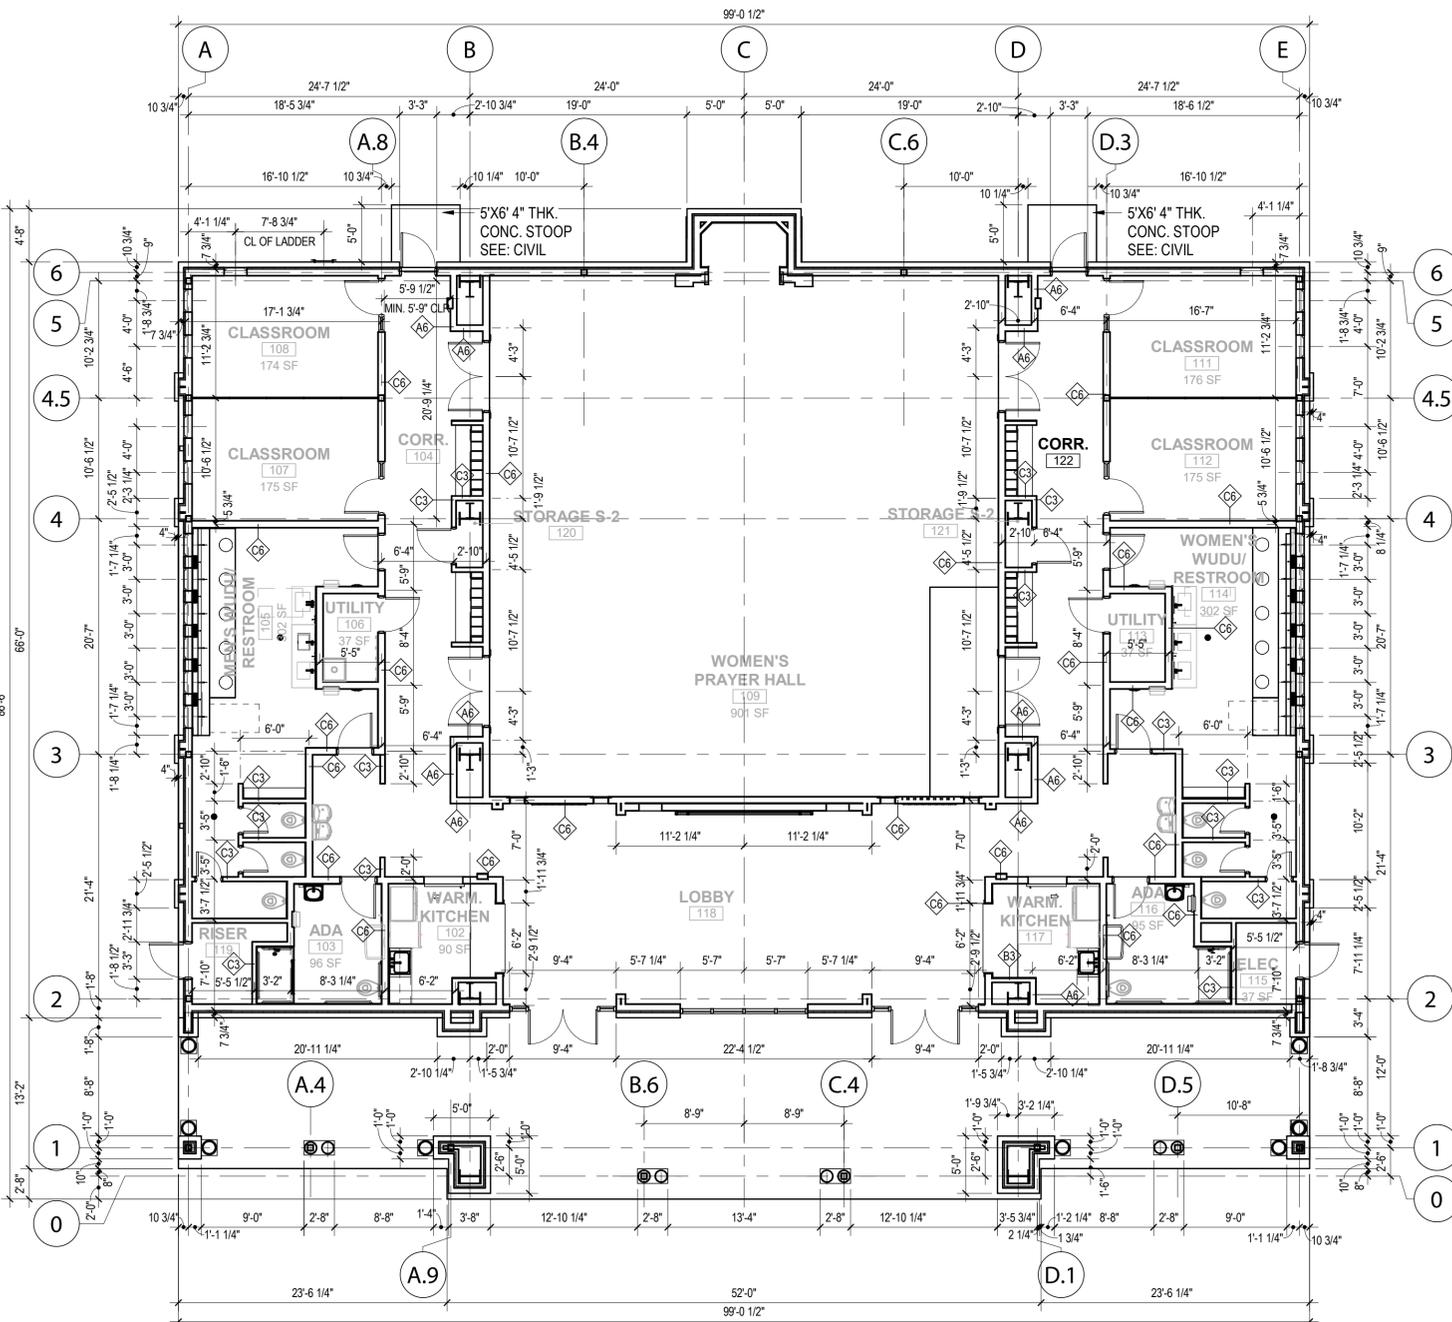

1 WALL TYPE / DIMENSION FLOOR PLAN  
1/8" = 1'-0"

2 WALL TYPE / DIMENSION FLOOR PLAN - UPPER PRAYER ROOM  
1/8" = 1'-0"

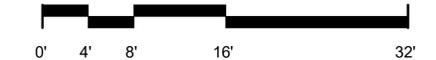

Rev.	Description	Date

Job Number: 22073  
Date: September, 2025  
Drawn By: EA, OS, MM  
Checked By: MM

Project Title:  
**AUBURN ISLAMIC CENTER  
MOSQUE**  
740 MILL CREEK ROAD  
AUBURN, AL 36832

Sheet Title:  
WALL TYPE PLAN  
Sheet Number:  
**A02.01**

95%  
SUBMITTAL  
NOT FOR  
CONSTRUCTION  
USE